

GIS REGISTRY INFORMATION

SITE NAME:	Northwest Engine & Chassis			FID #	
BRRS #:	03-55-215305			(if appropriate):	
COMMERCE # (if appropriate):	54819-9999-22				
CLOSURE DATE:	November 21, 2003				
STREET ADDRESS:	122 W Railroad Ave				
CITY:	Bruce				
SOURCE PROPERTY GPS COORDINATES (meters in WTM91 projection):		X =	420399	Y =	554576
CONTAMINATED MEDIA:	Groundwater	<input type="checkbox"/>	Soil	<input checked="" type="checkbox"/>	Both
OFF-SOURCE GW CONTAMINATION >ES:	Yes	<input type="checkbox"/>	No	<input checked="" type="checkbox"/>	
• IF YES, STREET ADDRESS:					
• GPS COORDINATES (meters in WTM91 projection):		X =		Y =	
OFF-SOURCE SOIL CONTAMINATION >Generic or Site-Specific RCL (SSRCL):		Yes	<input type="checkbox"/>	No	<input checked="" type="checkbox"/>
• IF YES, STREET ADDRESS 1:					
• GPS COORDINATES (meters in WTM91 projection):		X =		Y =	
CONTAMINATION IN RIGHT OF WAY:		Yes	<input type="checkbox"/>	No	<input checked="" type="checkbox"/>
<u>DOCUMENTS NEEDED</u>					
Closure Letter, and any conditional closure letter issued					X
Copy of most recent deed, including legal description, for all affected properties					X
Certified survey map or relevant portion of the recorded plat map (if referenced in the legal description) for all affected properties					X
County Parcel ID number, if used for county, for all affected properties					X
Location Map which outlines all properties within contaminated site boundaries on USGS topographic map or plat map in sufficient detail to permit the parcels to be located easily (8.5x14" if paper copy). If groundwater standards are exceeded, the map must also include the location of all municipal and potable wells within 1200' of the site.					X
Detailed Site Map(s) for all affected properties , showing buildings, roads, property boundaries, contaminant sources, utility lines, monitoring wells and potable wells. (8.5x14", if paper copy) This map shall also show the location of all contaminated public streets, highway and railroad rights-of-way in relation to the source property and in relation to the boundaries of groundwater contamination exceeding ch. NR 140 ESs and soil contamination exceeding ch. NR 720 generic or SSRCLs.					X
Tables of Latest Groundwater Analytical Results (no shading or cross-hatching)					X
Tables of Latest Soil Analytical Results (no shading or cross-hatching)					X
Isoconcentration map(s), if required for site investigation (SI) (8.5x14" if paper copy). The isoconcentration map should have flow direction and extent of groundwater contamination defined. If not available, include the latest extent of contaminant plume map.					X
GW: Table of water level elevations, with sampling dates, and free product noted if present					X
GW: Latest groundwater flow direction/monitoring well location map (should be 2 maps if maximum variation in flow direction is greater than 20 degrees)					X
SOIL: Latest horizontal extent of contamination exceeding generic or SSRCLs, with one contour					X
Geologic cross-sections, if required for SI. (8.5x14' if paper copy)					X
RP certified statement that legal descriptions are complete and accurate					X
Copies of off-source notification letters (if applicable)					X
Letter informing ROW owner of residual contamination (if applicable)(public, highway or railroad ROW)					X
Copy of (soil or land use) deed restriction(s) or deed notice if any required as a condition of closure					X



ENVIRONMENTAL & REGULATORY SERVICES DIVISION
BUREAU OF PECFA
P.O. Box 8044
Madison, Wisconsin 53708-8044
TDD #: (608) 264-8777
Fax #: (608) 267-1381
<http://www.commerce.state.wi.us>
<http://www.wisconsin.gov>
Jim Doyle, Governor
Cory L. Nettles, Secretary

November 21, 2003

Jeff Kisling
Northwest Engine & Chassis
122 W Railroad Ave
Bruce, WI 54819

RE: **Final Closure**

Commerce # 54819-9999-22 **WDNR BRRTS # 03-55-215305**
Northwest Engine & Chassis, 122 W Railroad Ave, Bruce

Dear Mr. Kisling:

The Wisconsin Department of Commerce (Commerce) has received all items required as conditions for closure of the site referenced above. This case is now listed as "closed" on the Commerce database and will be included on the Wisconsin Department of Natural Resources (WDNR) Geographic Information System (GIS) Registry of Closed Remediation Sites to address residual contamination. It is in your best interest to keep all documentation related to the environmental activities that were conducted.

If residual contamination is encountered in the future, it must be managed in accordance with all applicable state and federal regulations. If it is determined that any remaining contamination poses a threat, the case may be reopened and further investigation or remediation may be required.

Thank you for your efforts to bring this case to closure. If you have any questions, please contact me in writing at the letterhead address or by telephone at (608) 261-7718.

Sincerely,

Will M. Myers
Geologist
Site Review Section

cc: Dale Kauzlaric, Envirogen, Inc.

256844

Vol 342 Pl 844

WARRANTY DEED

STATE OF WISCONSIN — FORM 2

DOCUMENT NO.

REGISTER'S OFFICE
RUSK COUNTY

Received for Record the 27th day of May A.D. 1998
at 1:00 o'clock P. M. and
recorded in Vol. 342 of
Records on page 844
Linda Ann Effertz
Register of Deeds

INDEXED

THIS SPACE RESERVED FOR RECORDING DATA

NAME AND RETURN ADDRESS

FEE
\$71.25(2)
EXEMPT

This indenture, Made this _____ day of May
A.D. 1998, between Village of Bruce, a Wisconsin
Municipal Corporation, ~~XXXXXX~~
~~XXXXXX~~ located at
Bruce, Wisconsin, party of the first part, and
Jeffrey Kisling

part Y of the second part.

Witnesseth, That the said party of the first part, for and in consideration of the sum of \$1.00 and other good and valuable consideration to it paid by the said part Y of the second part, the receipt whereof is hereby confessed and acknowledged, has given, granted, bargained, sold, remised, released, aliened, conveyed and confirmed, and by these presents does give, grant, bargain, sell, remise, alien, convey, and confirm unto the said part Y of the second part, his heirs and assigns forever, the following described real estate, situated in the County of Rusk, State of Wisconsin, to-wit: Lots Eight (8), Nine (9) and Ten (10) and the South 15 feet of Lot Seven (7), Block Five (5) or the Original Plat of the Village of Bruce.

This deed is given in fulfillment of that certain land contract between the above named parties dated February 10, 1987 and recorded February 10, 1987 in the office of the Register of Deeds in and for Rusk County, Wisconsin, appearing in Volume 243 of Records at Pages 659-660 as Document No. 215709.

(IF NECESSARY, CONTINUE DESCRIPTION ON REVERSE SIDE)

Together with all and singular the hereditaments and appurtenances thereunto belonging or in any wise appertaining; and all the estate, right, title, interest, claim or demand whatsoever, of the said party of the first part, either in law or equity, either in possession or expectancy of, in and to the above bargained premises, and their hereditaments and appurtenances.

To have and to hold the said premises as above described with the hereditaments and appurtenances, unto the said part Y of the second part, and to his heirs and assigns FOREVER.

And the said Village of Bruce

party of the first part, for itself and its successors, does covenant, grant, bargain and agree to and with the said part Y of the second part, his heirs and assigns, that at the time of the sealing and delivery of these presents it is well seized of the premises above described, as of a good, sure, perfect, absolute and indefeasible estate of inheritance in the law, in fee simple, and that the same are free and clear from all encumbrances whatever, except restrictions, reservations and easements of record, if any.

and that the above bargained premises in the quiet and peaceable possession of the said part Y of the second part, his heirs, and assigns, against all and every person or persons lawfully claiming the whole or any part thereof, it will forever WARRANT and DEFEND.

In Witness Whereof, the said Village of Bruce

party of the first part, has caused these presents to be signed by Rodney Keith, its President, and countersigned by Pamela Skowzgard, its Clerk, ~~XXXXXX~~
at Bruce, Wisconsin, and its corporate seal to be hereunto affixed this
15th day of May, A.D. 19 98.

SIGNED AND SEALED IN THE PRESENCE OF

VILLAGE OF BRUCE

Corporate Name

Rodney Keith

President

COUNTERSIGNED:

Pamela Skowzgard, Clerk ~~XXXXXX~~

State of Wisconsin,

ss.

Rusk County.

Personally came before me, this 15th day of May, A.D. 1998,
Rodney Keith, President, and Pamela Skowzgard, Clerk, ~~XXXXXX~~

of the above named Corporation, to me known to be the persons who executed the foregoing instrument, and to me known to be such President and Secretary of said Corporation, and acknowledged that they executed the foregoing instrument as such officers as the deed of said Corporation, by its authority.

THIS INSTRUMENT WAS DRAFTED BY
WEILER LAW OFFICE
Michael P. Weiler, Atty.
Ladysmith, WI 54848

NOTARY
SEAL

Notary Public, Rusk County, Wis.
My commission (expires) (X) 5-28-2000

(Section 59.51 (1) of the Wisconsin Statutes provides that all instruments to be recorded shall have plainly printed or typewritten thereon the names of the grantors, grantees, witnesses and notary. Section 59.513 similarly requires that the name of the person who, or governmental agency which, drafted such instrument, shall be printed, typewritten, stamped or written thereon in a legible manner.)

WARRANTY DEED — By Corporation

STATE OF WISCONSIN
Form No. 2Wisconsin Legal Blank Co., Inc.
Milwaukee, Wis.

BOOK	STATE NO	PAGE	YEAR
1	54-106	15	2003

REAL ESTATE ASSESSMENT ROLL FOR THE VILLAGE OF BRUCE


KEY TO
CODES

1 A - RESIDENTIAL	4 D - AGRIC
2 B - COMMERCIAL	5 E - SWAN
3 C - MANUFACTURING	6 F - PROD

COMPUTER NUMBER PARCEL NUMBER		SCHOOL DIST	VOL/PAGE - REG. DEEDS		TOTAL ACRES OF DESC	ACREAGE & VALUE (SUBJECT TO GENERA	
NAME & ADDRESS			SEC. TN. RANGE DESCRIPTION OF PROPERTY			ACRES	LAND VALUE
1	106- 91-00000	735	WD 342/ 844 5-34N- 7W 106W RAILROAD AVE VILLAGE OF BRUCE S 15' OF LOT 7 BLOCK 5 & LOTS 8 & 9 & 10 BLOCK 5 VOLUME 342 PAGE 844		2		16000
2	106- 92-00000	735	5-34N- 7W 126W RAILROAD AVE VILLAGE OF BRUCE LOTS 11, 12 & 13 BLOCK 5 VOLUME 246 PAGE 243		2		14000
3	106- 93-00000	735	WD 417/ 758 5-34N- 7W VILLAGE OF BRUCE LOT 14 BLOCK 5 VOLUME 417 PAGE 758		1		2800
4	106- 94-00000	735	WD 417/ 758 5-34N- 7W 834N ALVEY ST VILLAGE OF BRUCE LOT 15 & 16 BLOCK 5 VOLUME 417 PAGE 758		1		5600
5	106- 95-00000	735	5-34N- 7W 908N ALVEY ST VILLAGE OF BRUCE LOT 17 BLOCK 5 VOLUME 211 PAGE 472		1		2800
6	106- 96-00000	735	TERM 407/ 558A 5-34N- 7W 914N ALVEY ST VILLAGE OF BRUCE LOT 18 BLOCK 5 VOLUME 407 PAGE 558A		1		2800
7	106- 97-00000	735	TERM 407/ 552 5-34N- 7W 920N ALVEY ST VILLAGE OF BRUCE LOTS 19 & 20 BLOCK 5 VOLUME 407 PAGE 552		1		5600
8	106- 98-00000	735	WD 388/ 444 5-34N- 7W 928N ALVEY ST LE HARRIET FUGLSANG VILLAGE OF BRUCE LOT 21 BLOCK 5 VOLUME 388 PAGE 444		1		2800
9	106- 99-00000	735	5-34N- 7W 929N ALVEY ST VILLAGE OF BRUCE LOT 1 BLOCK 6 VOLUME 182 PAGE 294		1		2800

NO. OF PARCELS


TOTALS

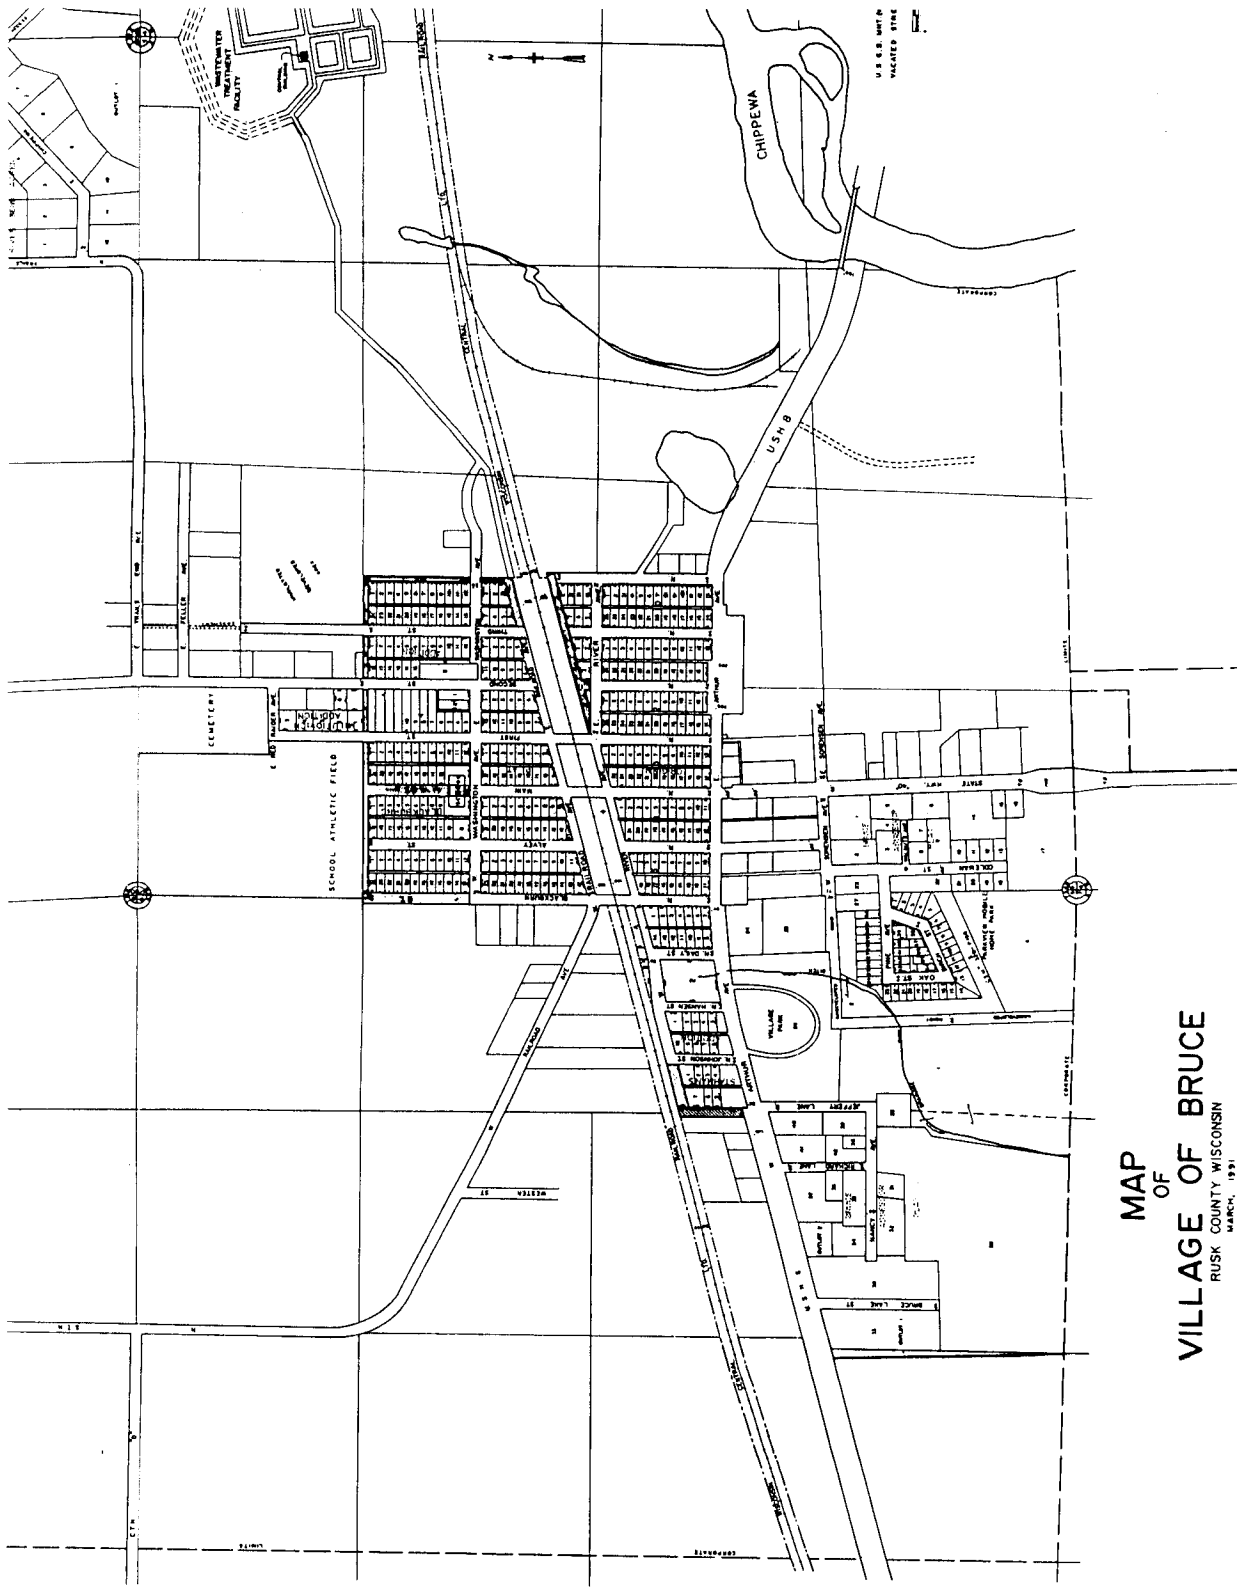


MAP
OF
VILLAGE OF BRUCE
RUSK COUNTY WISCONSIN
MARCH, 1931

12th day of August, 2013
Jenny Hegelberg
Clerk/Treasurer
Village of Bruce


12th day of August, 2003
Jerry K. Gehl
Clerk/Treasurer
Village of Bruce

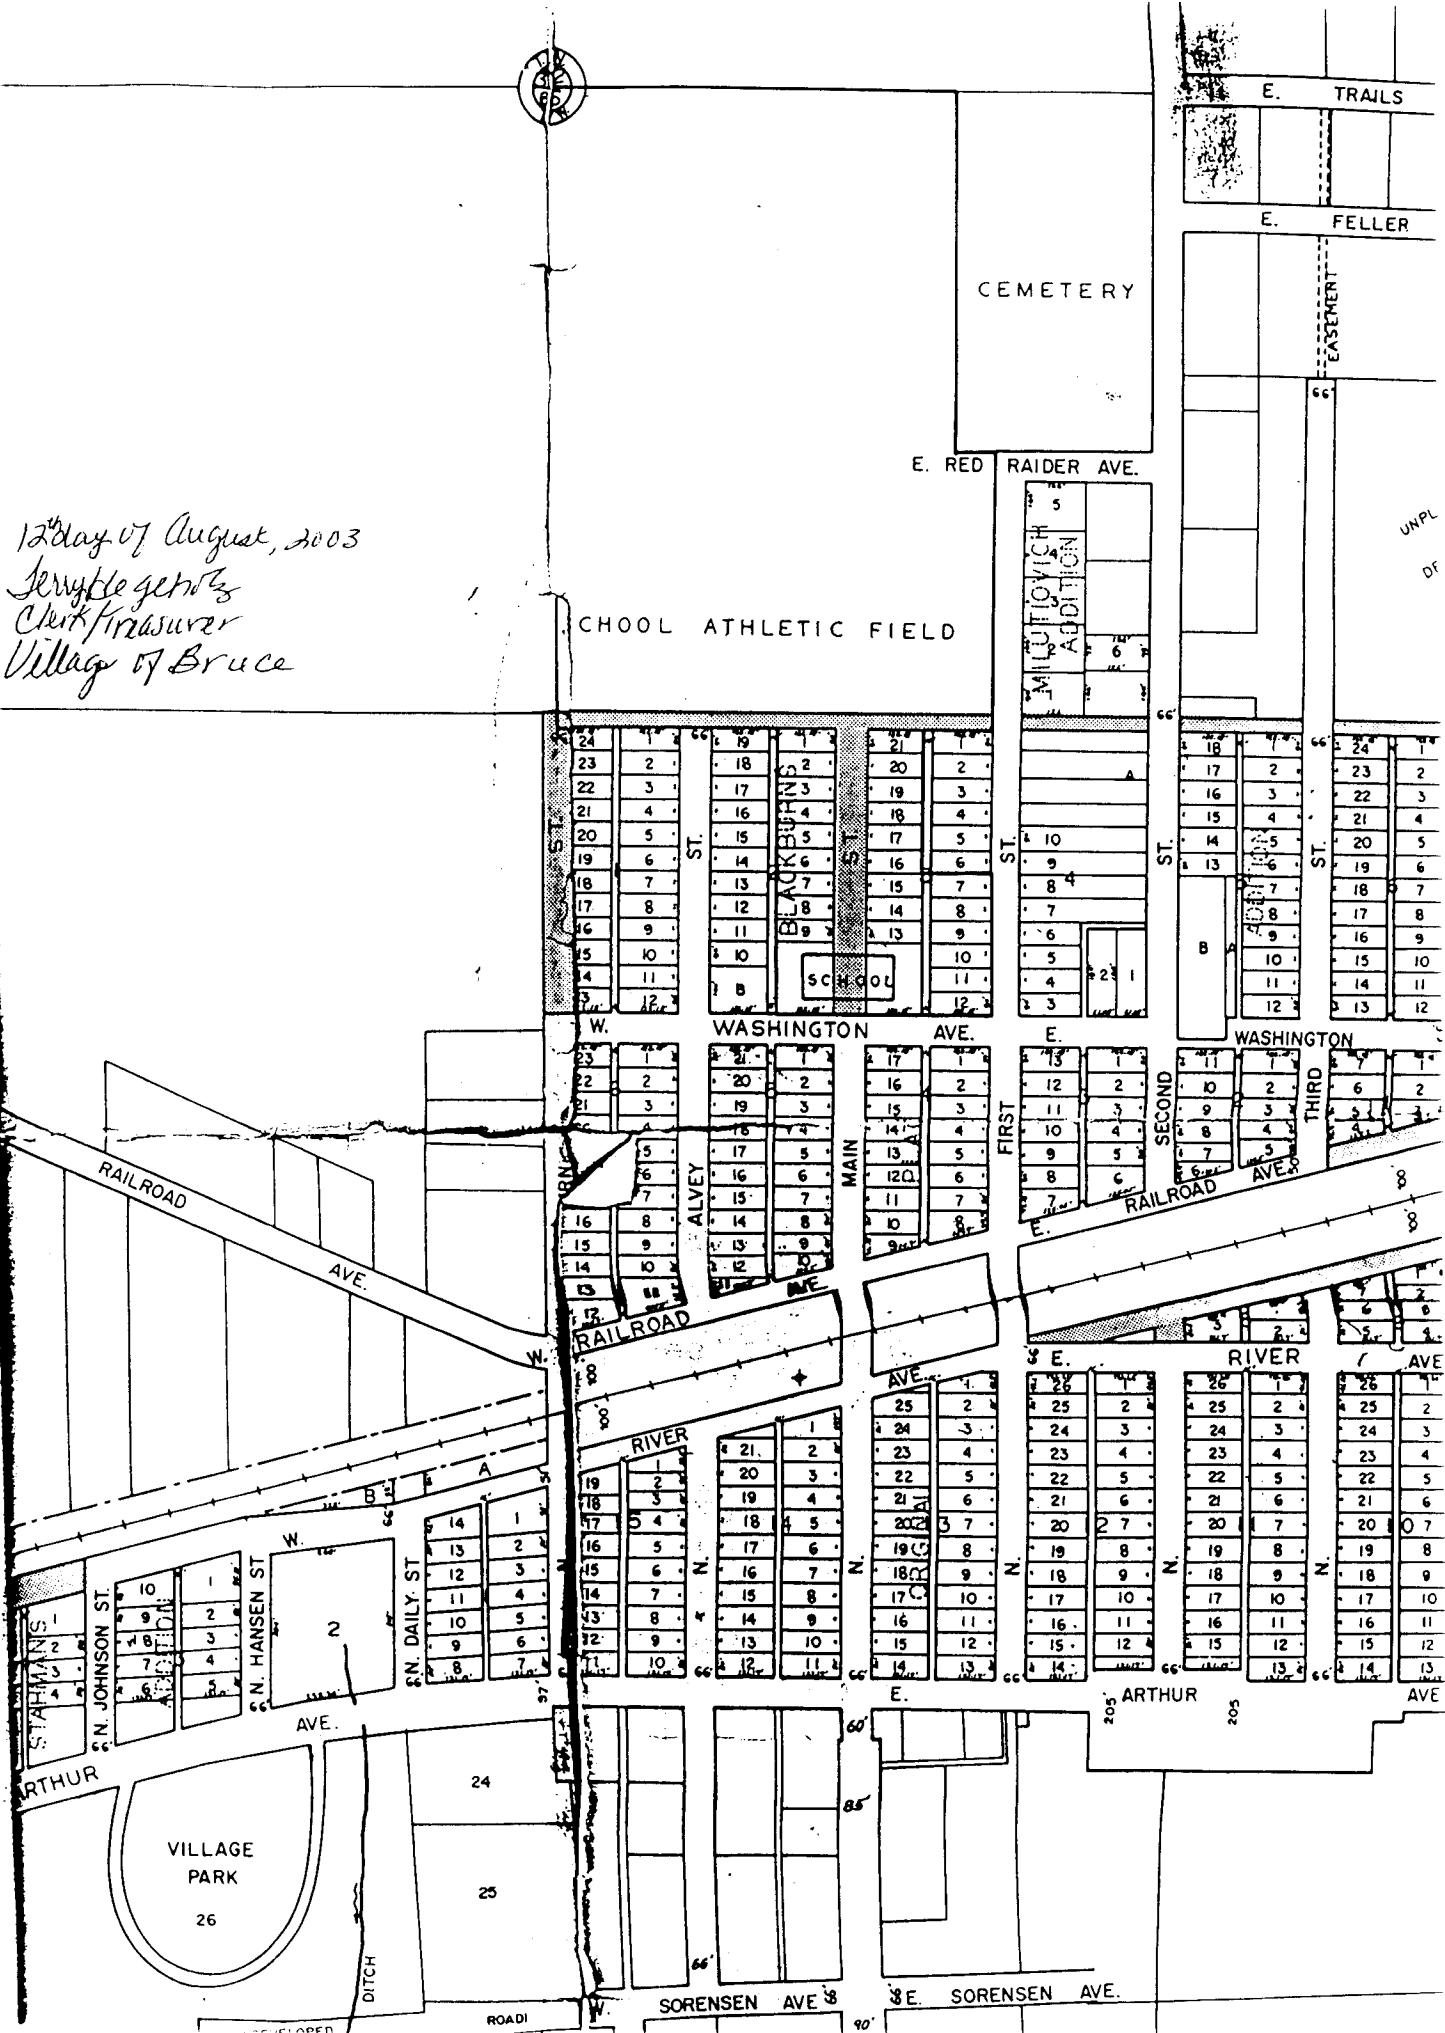

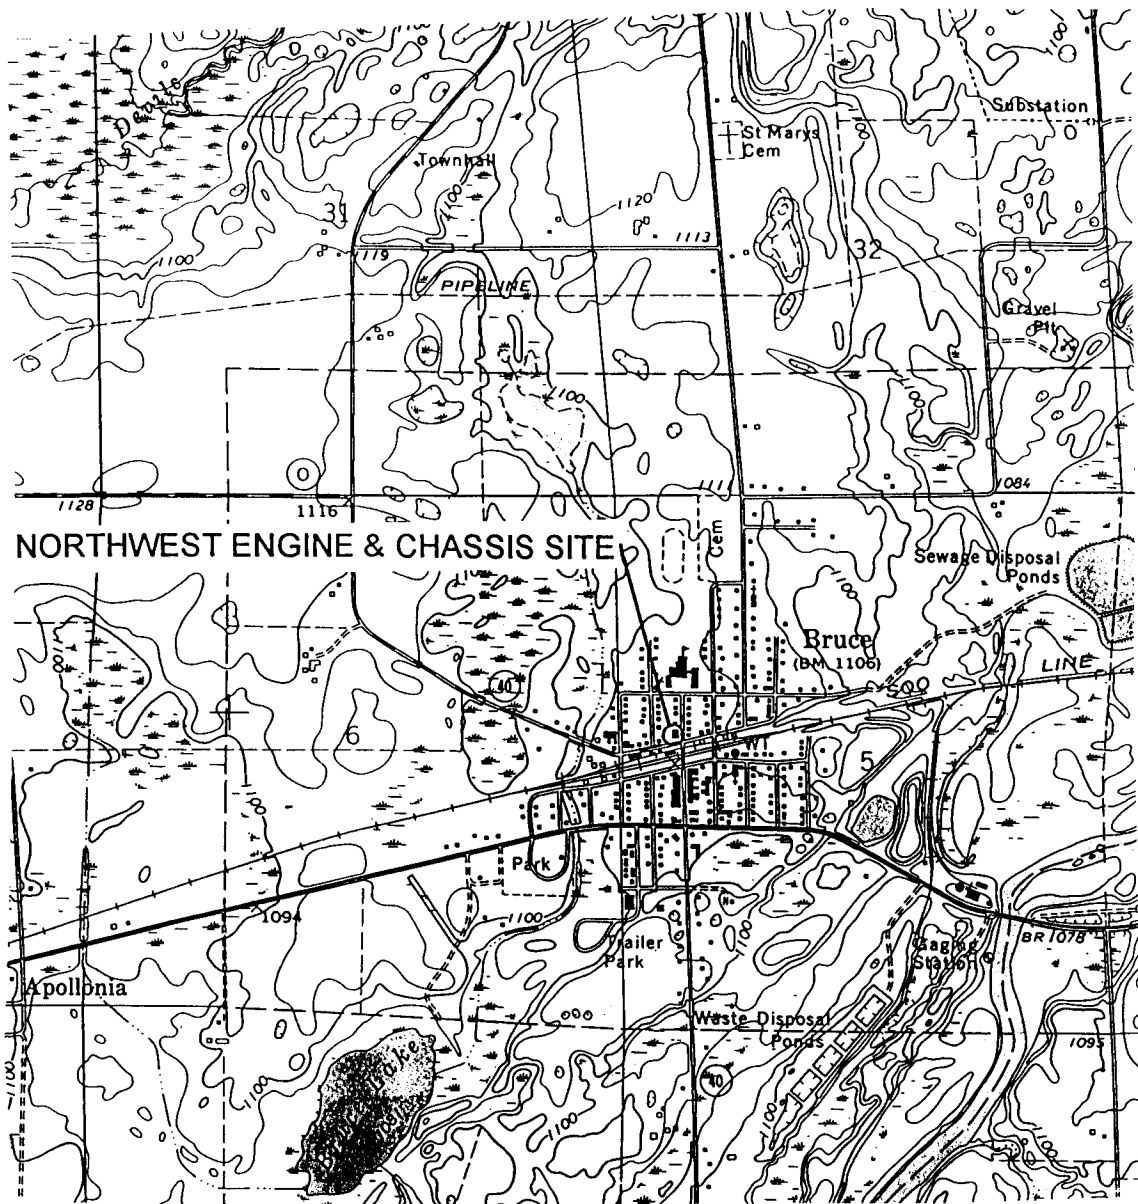

NORTHWEST ENGINE & CHASSIS SITE

(USGS 1972) SCALE
BRUCE QUADRANGLE 1:24000

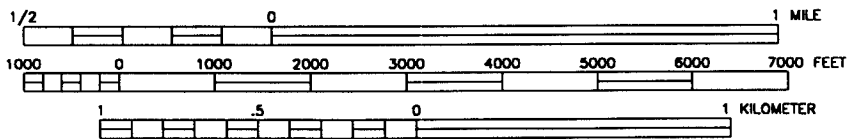

CONTOUR INTERVAL 10 FEET



LOCATION



ENVIROGEN

COST EFFECTIVE LEADERSHIP FOR A CLEANER ENVIRONMENT

850 Hwy 153 Suite F
Mosinee, Wisconsin 54455

SITE LOCATION MAP

NORTHWEST ENGINE & CHASSIS SITE
BRUCE, WISCONSIN


FIGURE NO.

1

ENGINEER	DATE
ENGINEER	DATE
REVISIONS:	
APPROVED BY:	
CHECKED BY:	
KFT	02/12/03
DRAWN BY:	
DRAWING NO.	990036L1

A 500-GALLON FUEL OIL UST
B 500-GALLON HEATING OIL UST

— — — — —	PROPERTY BOUNDARY
	FIRE HYDRANT
	UTILITY POLE
	MANHOLE
— OE —	OVERHEAD ELECTRIC LINE
— T —	TELEPHONE LINE
— G —	NATURAL GAS
— W —	WATER LATERAL
— S —	SEWER LATERAL
— STM —	STORM SEWER

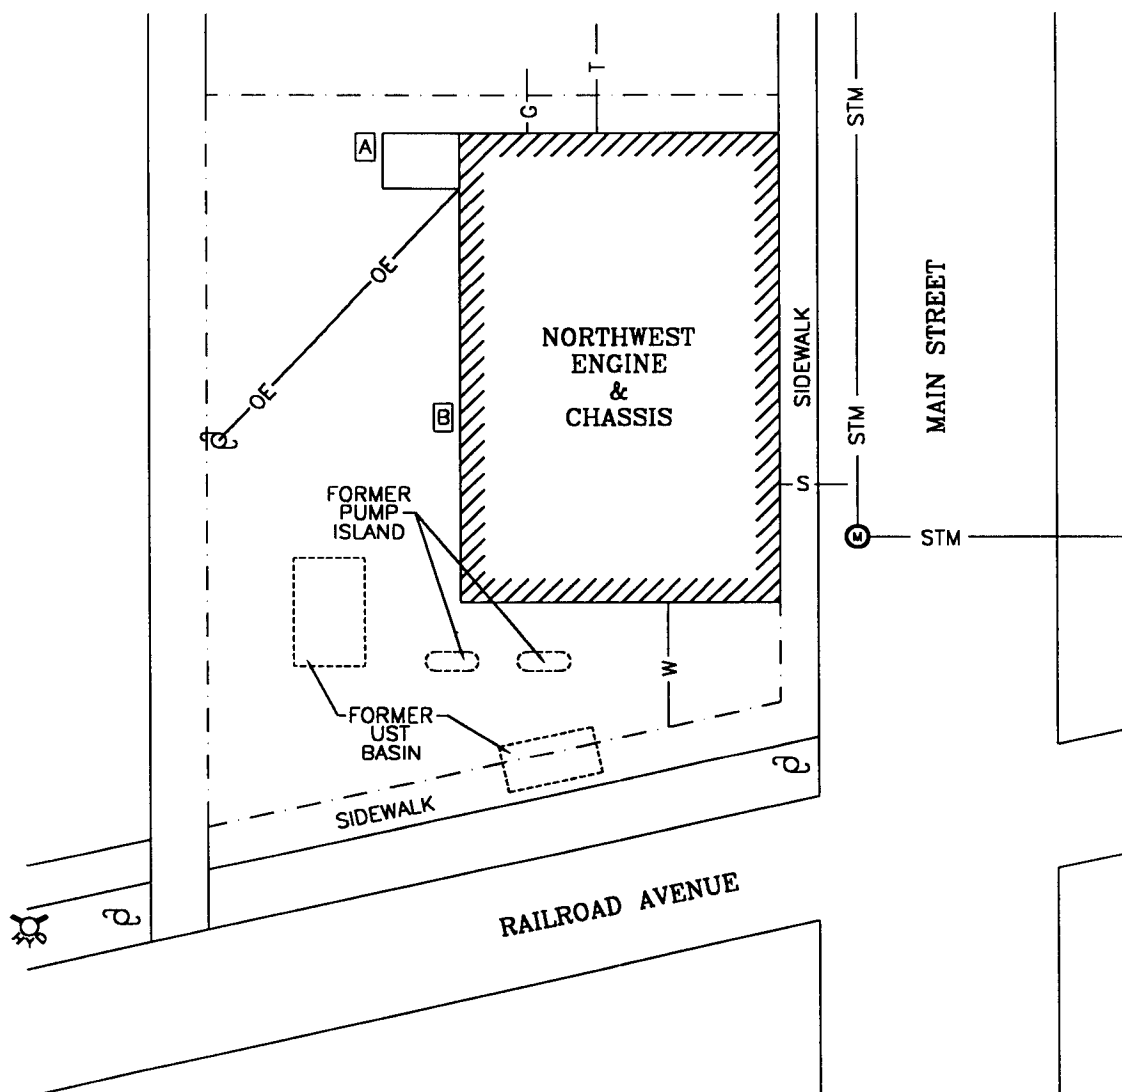


ENVIROGEN

COST EFFECTIVE LEADERSHIP FOR A CLEANER ENVIRONMENT

850 Hwy 153 Suite F
Mosinee, Wisconsin 54455

SCALE

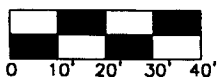

SITE PLAN VIEW

FIGURE NO.

NORTHWEST ENGINE & CHASSIS SITE
BRUCE, WISCONSIN

2


DRAWING NO	99003612	DRAWN BY:	KFT	02/2/03	CHECKED BY:	APPROVED BY:	ENGINEER	DATE
							ENGINEER	DATE
REVISIONS:								

TANK LEGEND

- A 500-GALLON FUEL OIL UST
- B 500-GALLON HEATING OIL UST

LEGEND

- — — — — PROPERTY BOUNDARY
- GEOPROBE BORING LOCATION
- ⊕ MONITORING WELL LOCATION

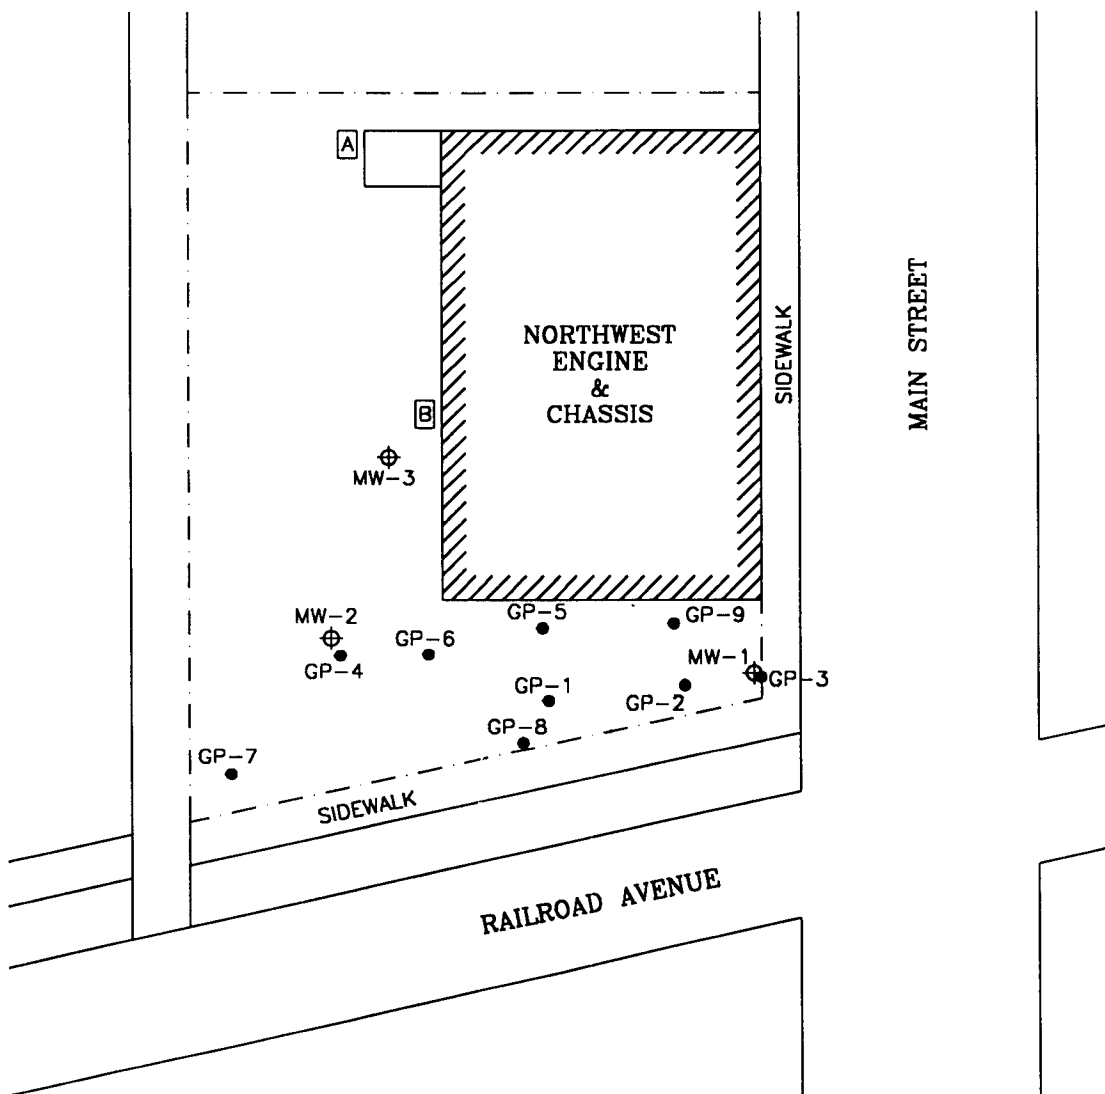

ENVIROGEN

COST EFFECTIVE LEADERSHIP FOR A CLEANER ENVIRONMENT

850 Hwy 153 Suite F
Mosinee, Wisconsin 54455

DATE	ENGINEER	DATE	ENGINEER	REVISIONS:	APPROVED BY:	CHECKED BY:	02/12/03	KFT	DRAWN BY:	990036L4	DRAWING NO.
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GEOPROBE BORING/ MONITORING WELL CONFIGURATION
NORTHWEST ENGINE & CHASSIS SITE BRUCE, WISCONSIN

FIGURE NO.

4

TABLE 4

**Groundwater Sample Laboratory Analytical Results
Northwest Engine & Chassis Site
Bruce, Wisconsin**

MW-1	Top of Well Screen: 90.6				Length of Well Screen: 10 Feet						
Sample Date	GRO	Benzene	Ethylbenzene	Toluene	Xylenes	TMBs	MTBE	Lead	Water Level*		
6/14/00	<50	<0.50	<5.0	<8.0	<5.0	<10.0	<0.101	<5.0	86.49		
7/08/00	<50	<0.50	<5.0	<5.0	<5.0	<10.0	<0.5	NA	87.55		
MW-2	Top of Well Screen: 90.0				Length of Well Screen: 10 Feet						
6/14/00	<50	<0.50	<5.0	<8.0	<5.0	<10.0	<0.101	<5.0	89.04		
7/08/00	<50	<0.50	<5.0	<5.0	<5.0	<10.0	<0.5	NA	89.56		
MW-3	Top of Well Screen: 93.1				Length of Well Screen: 10 Feet						
6/14/00	<50	<0.50	<5.0	<8.0	<5.0	<10.0	<0.101	17.6	89.16		
7/08/00	<50	<0.50	<5.0	<5.0	<5.0	<10.0	<0.5	<5.0	89.72		
NR 140 ES	--	5	700	1,000	10,000	480	60	15	--		
NR 140 PAL	--	0.5	140	200	1,000	96	12	1.5	--		

Notes:

* Asterisk indicates water table well screen submerged below water table.
All results in ppb unless otherwise noted.

Bold Bold indicates value equals or exceeds the NR 140 enforcement standard

Italics Italics indicates value equals or exceeds the NR 140 preventive action limit

DRO: Diesel range organics GRO: Gasoline range organics

NA: Not analyzed

MTBE: Methyl t-butyl ether

TMB: Trimethylbenzene

Checked by: _____ Approved by: _____

TABLE 3

**Soil Sample Laboratory Analytical Results
Northwest Engine & Chassis Site
Bruce, Wisconsin
February 22, 2000**

Boring & Sample	Depth* (ft bls)	PID (ppm eq)	GRO (ppm)	Lead (ppm)	Benzene	Ethylbenzene	Toluene	Xylenes	1,2,4-TMB	1,3,5-TMB	MTBE
GP1-S	(6)	<10	75.4	6.48	<25	436	112	689	217	180	<25
GP1-S	(14)*	<10	31.4	4.30	<25	40.2	<25	113	102	268	<25
GP2-S	(6)	<10	<5.24	<1.05	<25	<25	<25	<25	<25	<25	<25
GP2-S	(15)*	10.9	<5.28	<1.06	<25	<25	35.2	62.7	<25	<25	<25
GP3-S	(6)	<10	<5.26	1.70	<25	<25	<25	<25	<25	<25	<25
GP3-S	(13.5)*	<10	124	1.37	<25	<25	<25	89.1	423	514	<25
GP3-S	(18)*	<10	<5.83	1.45	<25	<25	<25	<25	<25	<25	<25
GP4-S	(7)	11.2	114	4.21	48.9	441	527	1,650	614	678	<25
GP4-S	(13)*	<10	87.1	2.32	<25	308	53.8	1,030	503	473	<25
GP5-S	(6)	<10	<5.23	1.47	<25	<25	<25	<25	<25	<25	<25
GP5-S	(13)*	<10	<5.28	1.80	<25	<25	79.1	<25	<25	<25	38.3
GP6-S	(6)	<10	<5.30	1.71	<25	<25	<25	<25	<25	<25	<25
GP6-S	(13)*	<10	<5.28	2.67	<25	<25	<25	<25	<25	<25	<25
GP7-S	(7)	<10	<5.29	1.60	<25	<25	<25	<25	<25	<25	<25
GP7-S	(12)*	<10	<5.39	<1.08	<25	<25	<25	<25	<25	<25	<25
GP8-S	(6)	<10	<5.22	<1.04	<25	<25	<25	<25	<25	<25	<25
GP8-S	(13)*	<10	<6.11	2.20	<25	<25	<25	<25	<25	<25	<25
GP9-S	(7)	<10	<5.39	23.2	<25	<25	<25	<25	<25	<25	<25
NR 720.09 RCLs			100	50	5.5	2,900	1,500	4,100	--	--	--
NR 746.06 Table 1 (free product indicator)			--	--	8,500	4,600	38,000	42,000	83,000	11,000	--
NR 746.06 Table 2 (direct contact standard)			--	--	1,100	--	--	--	--	--	--

Notes:

*Data with asterisk indicates sample was taken at or below the historic measured high water table, based on monitoring well data.
Results in ppb unless otherwise noted

Bold Bold indicates value equals or exceeds the NR 720.09 or NR 746 Table 1 or 2 values

All volatile organic compound samples collected after March 1, 1996, were methanol-preserved.
The official WDNR reporting limit for these samples is 25 ppb.

GRO: Gasoline range organics MTBE: Methyl-tert-butyl-ether TMB: Trimethylbenzene
bls: below land surface ppb: parts per billion ppm: parts per million
ppm eq: part per million equivalent RCLs: Residual contaminant level

Checked by: _____ Approved by: _____

TABLE 3 (Continued)

**Soil Sample Laboratory Analytical Results
Northwest Engine & Chassis Site
Bruce, Wisconsin
June 6, 2000**

Boring & Sample	Depth* (ft bls)	PID (ppm eq)	GRO (ppm)	Lead (ppm)	Benzene	Ethylbenzene	Toluene	Xylenes	1,2,4- TMB	1,3,5- TMB	MTBE
MW1-S	(18-20)*	<10	5.73	<1.13	<25	<25	<25	<25	<25	<25	<25
MW1-S	(24-26)*	<10	5.90	<1.18	<25	<25	<25	<25	<25	<25	<25
MW2-S	(18-20)*	<10	7.30	1.59	<25	<25	<25	<25	<25	<25	<25
MW2-S	(24-26)*	<10	<5.62	<1.12	<25	<25	<25	<25	<25	<25	<25
MW3-S	(5-7)	<10	5.69	<1.06	<25	<25	<25	<25	<25	<25	<25
MW3-S	(10-12)	<10	5.82	<1.14	<25	<25	<25	<25	<25	<25	<25
MW3-S	(15-17)*	<10	<5.65	<1.13	<25	<25	<25	<25	<25	<25	<25
NR 720.09 RCLs			100	50	5.5	2,900	1,500	4,100	--	--	--
NR 746.06 Table 1 (free product indicator)			--	--	8,500	4,600	38,000	42,000	83,000	11,000	--
NR 746.06 Table 2 (direct contact standard)			--	--	1,100	--	--	--	--	--	--

Notes:

*Data with asterisk indicates sample was taken at or below the historic measured high water table, based on monitoring well data.
Results in ppb unless otherwise noted

Bold Bold indicates value equals or exceeds the NR 720.09 RCLs or NR 746 Table 1 or 2 values

The official WDNR reporting limit for these samples is 25 ppb.

All volatile organic compound samples collected after March 1, 1996, were methanol-preserved.

GRO: Gasoline range organics	MTBE: Methyl-tert-butyl-ether	TMB: Trimethylbenzene
bls: below land surface	ppb: parts per billion	ppm: parts per million
ppm eq: part per million equivalent	RCLs: Residual contaminant level	

Checked by: _____


Approved by: _____

TANK LEGEND

- A 500-GALLON FUEL OIL UST
- B 500-GALLON HEATING OIL UST

LEGEND

- — — — — PROPERTY BOUNDARY
- ⊕ MONITORING WELL LOCATION
- 89.00 ISOELEVATION CONTOUR

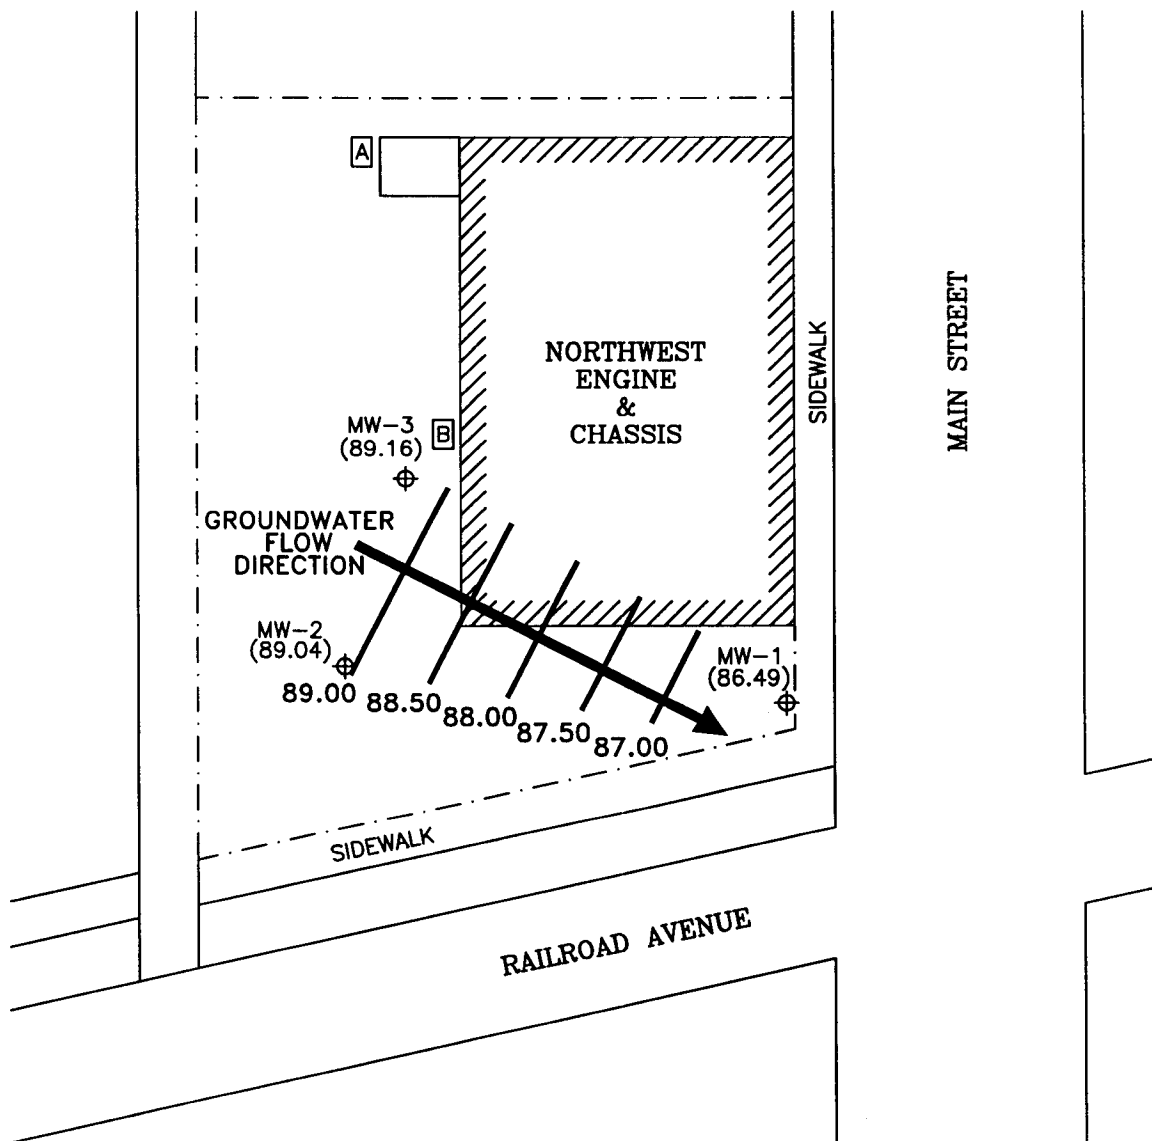

ENVIROGEN

COST EFFECTIVE LEADERSHIP FOR A CLEANER ENVIRONMENT

850 Hwy 153 Suite F
Mosinee, Wisconsin 54455

POTENTIOMETRIC SURFACE

(06/14/00)

NORTHWEST ENGINE & CHASSIS SITE

BRUCE, WISCONSIN

FIGURE NO.

10


ENGINEER	DATE
ENGINEER	DATE
REVISIONS:	
APPROVED BY:	
CHECKED BY:	
02/21/03	
KFT	
DRAWN BY:	
990036L10	
DRAWING NO.	

TANK LEGEND

- A 500-GALLON FUEL OIL UST
- B 500-GALLON HEATING OIL UST

LEGEND

- PROPERTY BOUNDARY
- GEOPROBE BORING LOCATION
- ⊕ MONITORING WELL LOCATION
- () GRO CONCENTRATION IN ppm
- 100 ISOCONCENTRATION CONTOUR

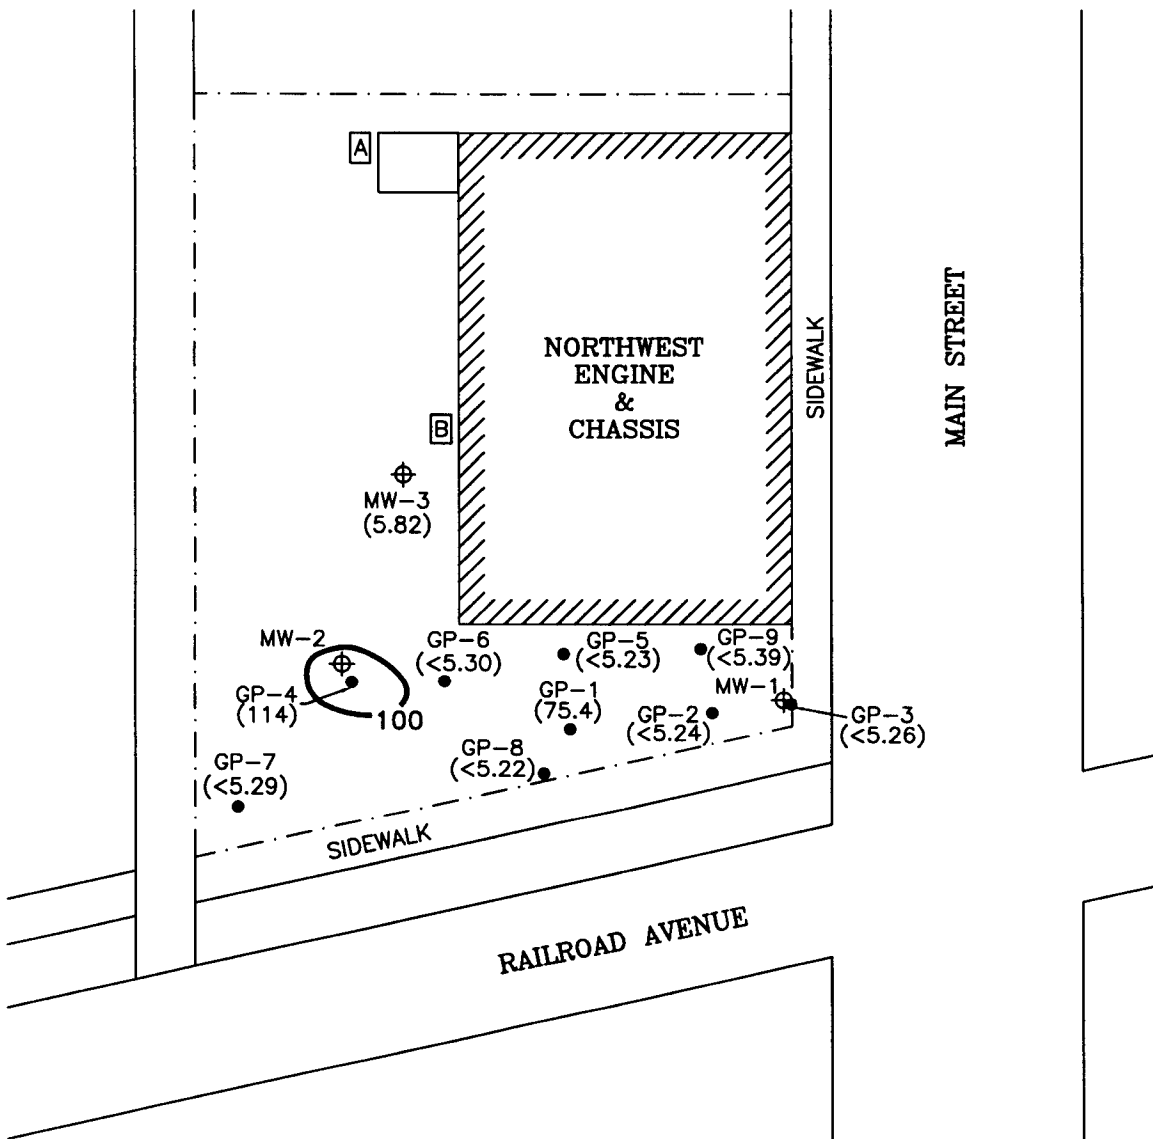

ENVIROGEN

COST EFFECTIVE LEADERSHIP FOR A CLEANER ENVIRONMENT

850 Hwy 153 Suite F
Mosinee, Wisconsin 54455

ENGINEER	DATE
ENGINEER	DATE
REVISIONS:	
APPROVED BY:	
CHECKED BY:	
02/21/03	
KFT	
DRAWN BY:	
990036L8	
DRAWING NO.	

SOIL GRO DISTRIBUTION
NORTHWEST ENGINE & CHASSIS SITE BRUCE, WISCONSIN

FIGURE NO.


8

TANK LEGEND

- A 500-GALLON FUEL OIL UST
- B 500-GALLON HEATING OIL UST

LEGEND

- — — — — PROPERTY BOUNDARY
- GEOPROBE BORING LOCATION
- ⊕ MONITORING WELL LOCATION

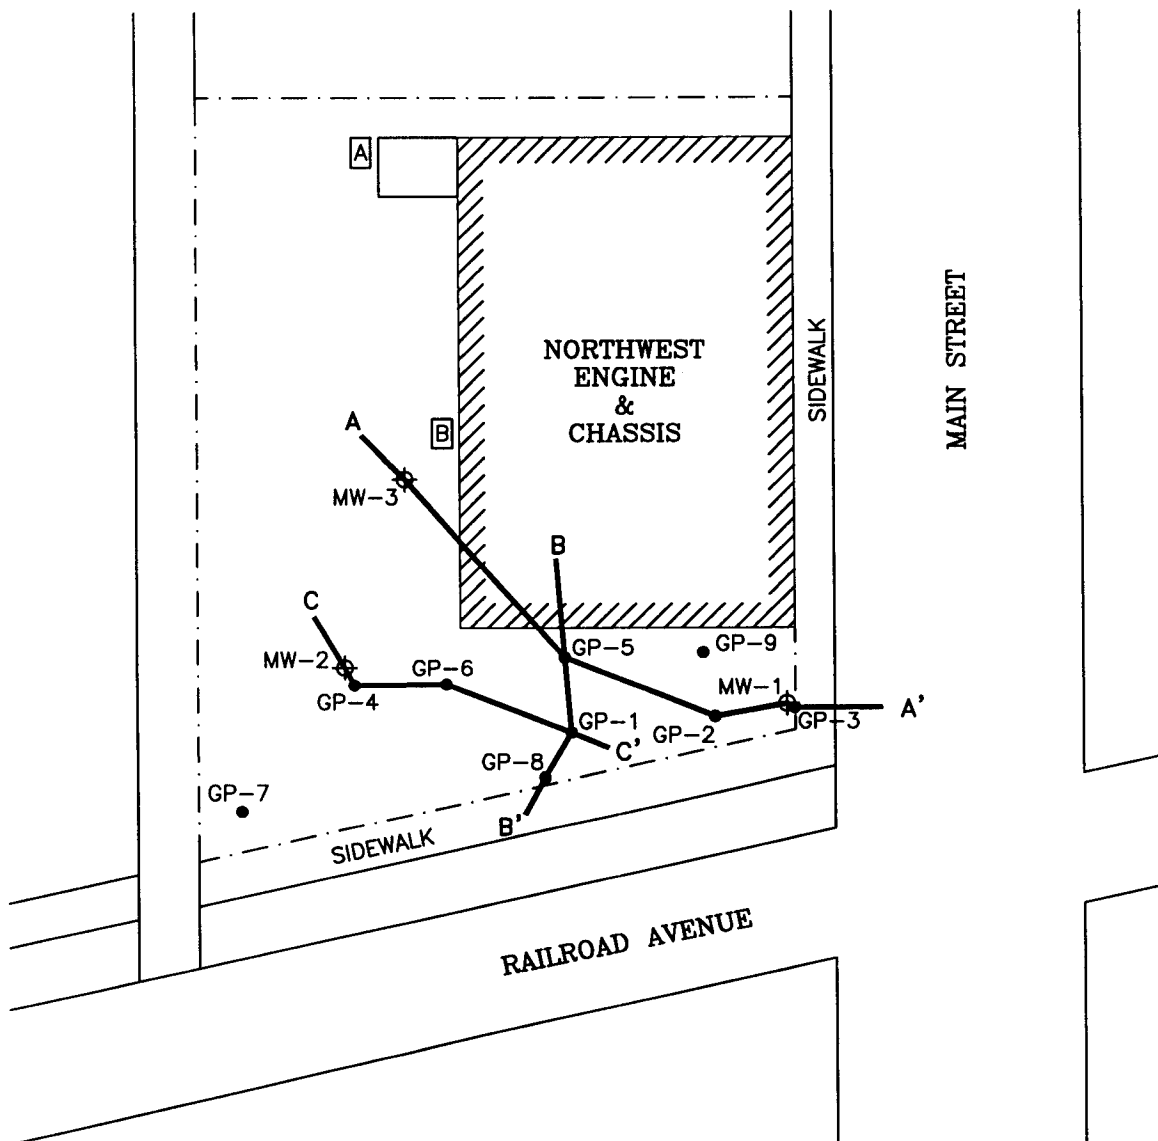


ENVIROGEN

COST EFFECTIVE LEADERSHIP FOR A CLEANER ENVIRONMENT

850 Hwy 153 Suite F
Mosinee, Wisconsin 54455

ENGINEER	DATE
ENGINEER	DATE
REVISIONS:	
APPROVED BY:	
CHECKED BY:	
02/21/03	
KFT	
DRAWN BY:	
990036L5	
DRAWING NO.	


CROSS SECTION	FIGURE NO. 5
PLAN VIEW	
NORTHWEST ENGINE & CHASSIS SITE BRUCE, WISCONSIN	

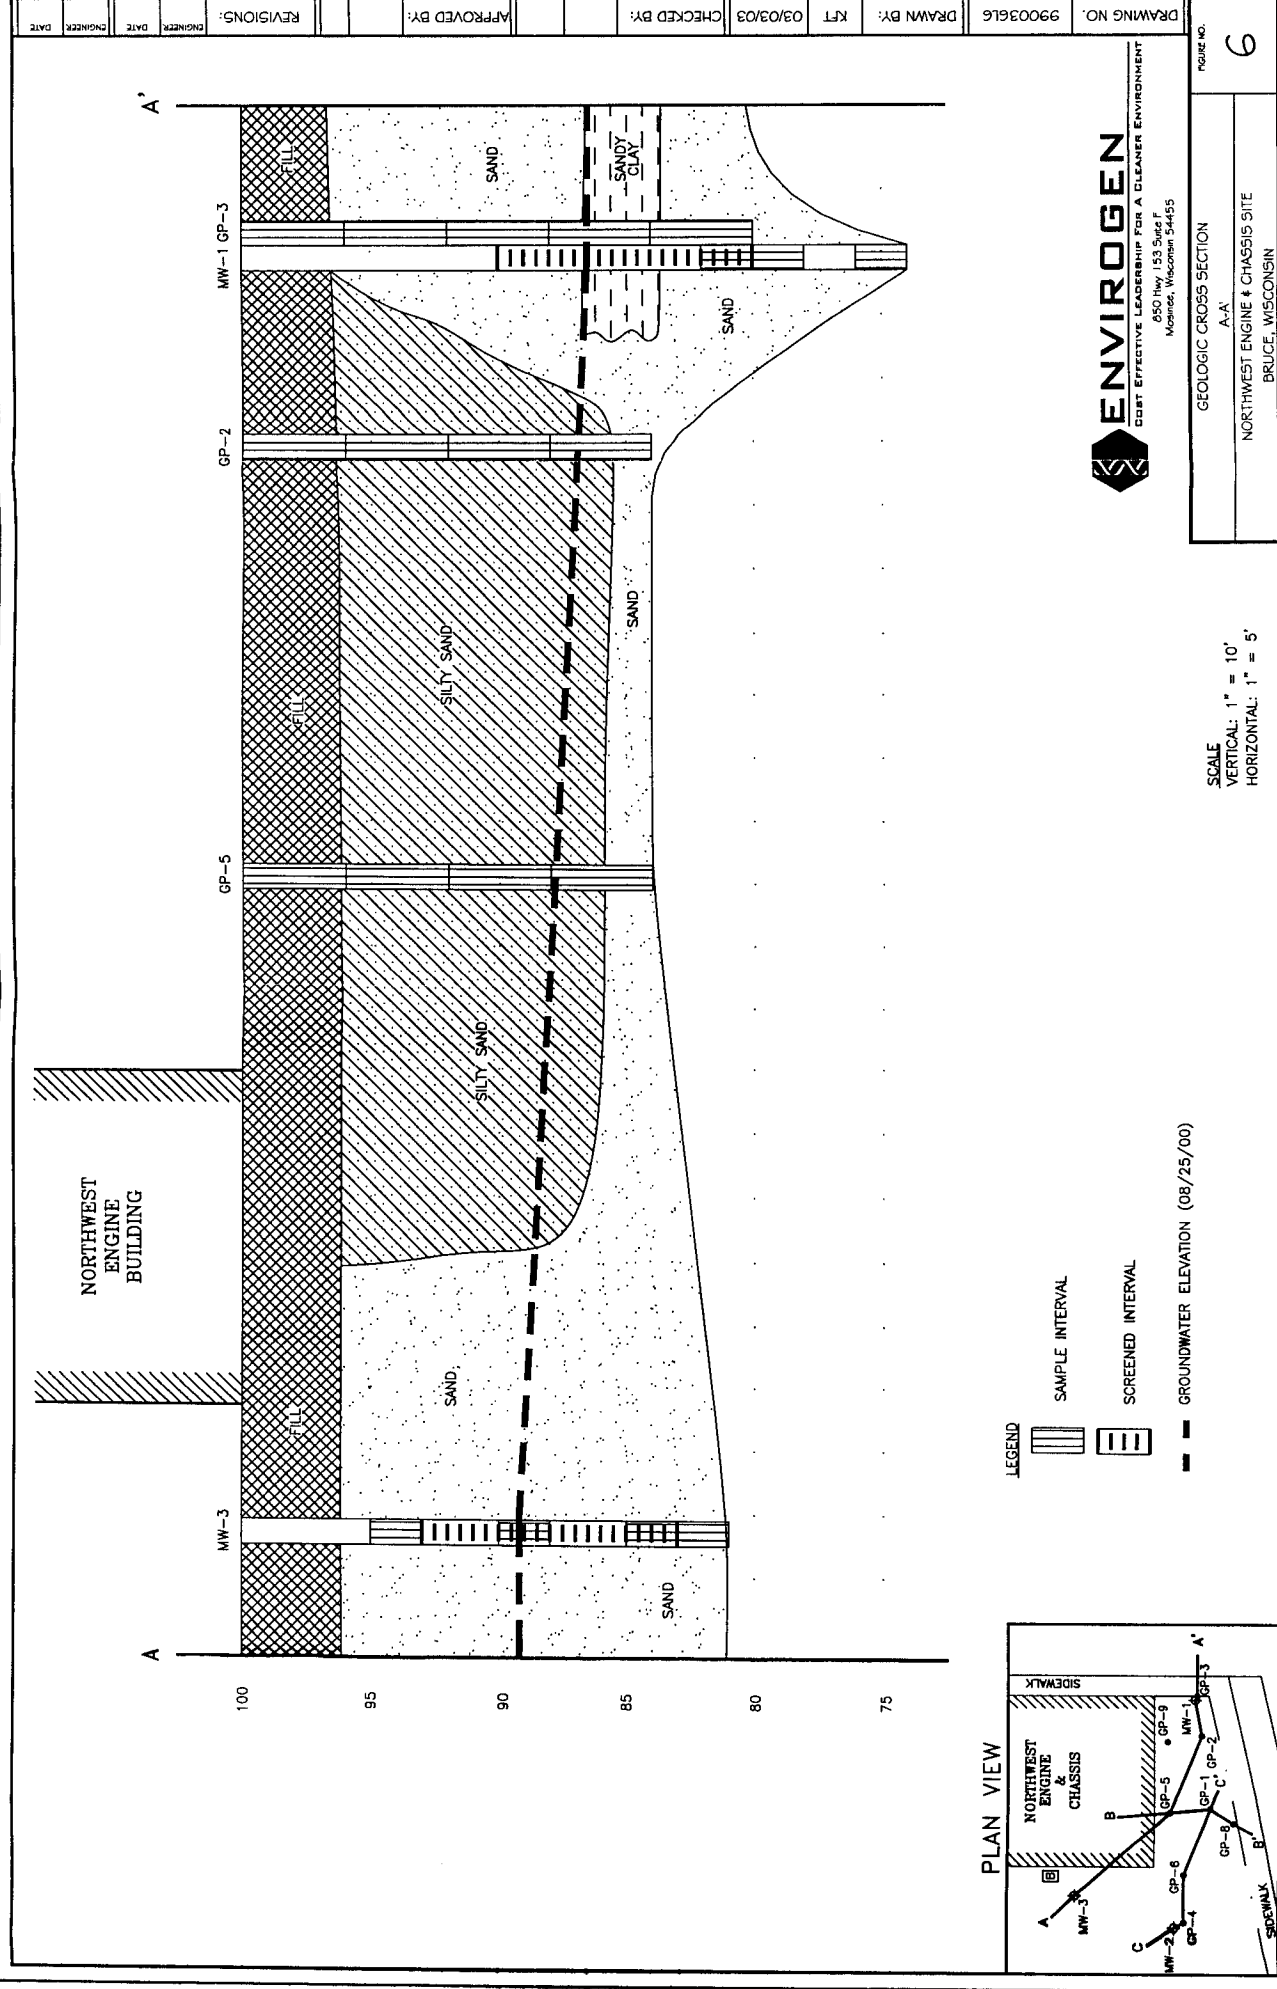


ENVIROGEN
BEST EFFECTIVE LEADERSHIP FOR A CLEANER ENVIRONMENT
650 Hwy 153 Suite F
Manitowish, Wisconsin 54455

DRAWING NO.	99003616
DRAWN BY:	KFT
CHECKED BY:	03/03/03
APPROVED BY:	
REVISIONS:	
ENGINEER	DATE
ENGINEER	DATE

PROJECT NO.	99003616
PROJECT NAME	NORTHWEST ENGINE & CHASSIS SITE
PROJECT LOCATION	BRUCE, WISCONSIN
SCALE	VERTICAL: 1" = 10'; HORIZONTAL: 1" = 5'
DATE	08/25/00

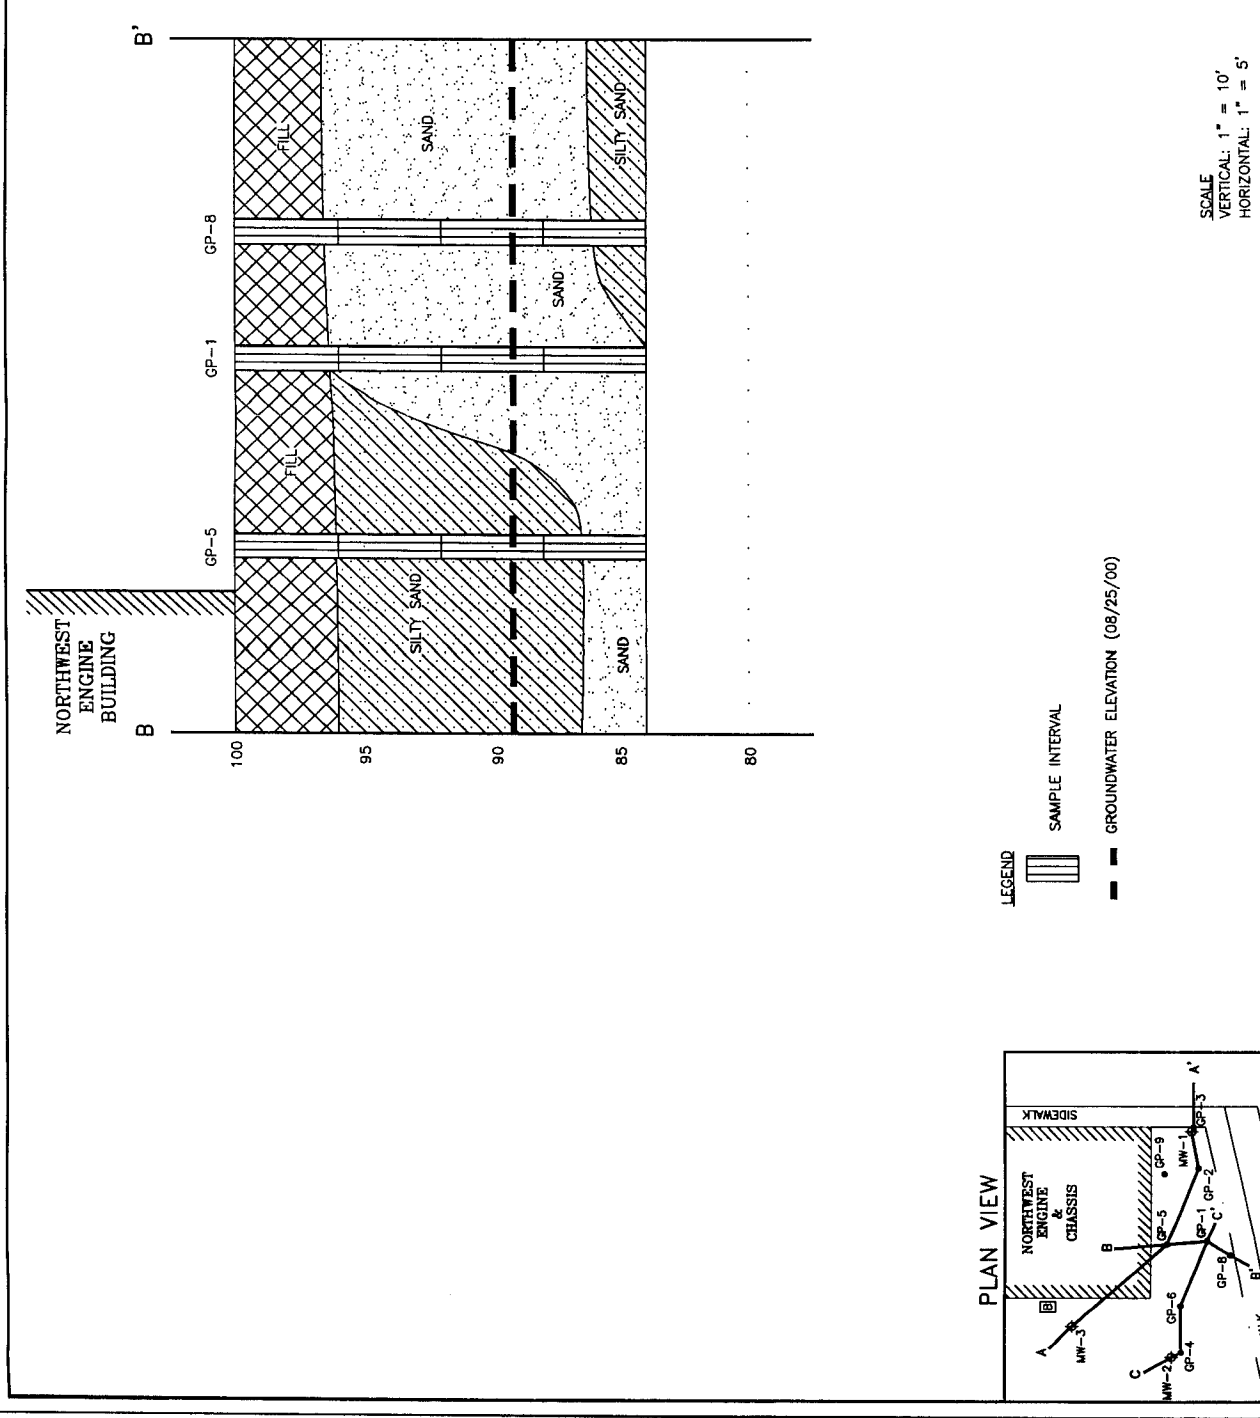





ENVIROGEN
COST EFFECTIVE LEADERSHIP FOR A CLEANER ENVIRONMENT
 950 Hwy 153 Suite F
 Menomonie, Wisconsin 54455

FIGURE NO. **6**

SOIL GRO DISTRIBUTION
 CROSS SECTION C-C'
 NORTHWEST ENGINE & CHASSIS SITE
 BRUCE, WISCONSIN

SCALE
 VERTICAL: 1" = 10'
 HORIZONTAL: 1" = 5'

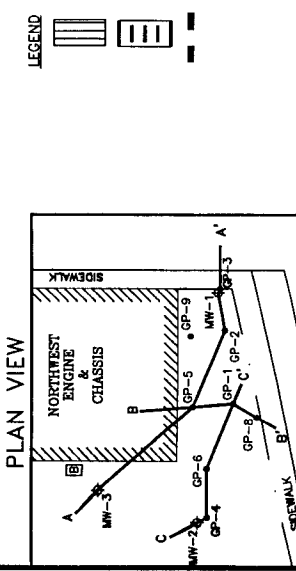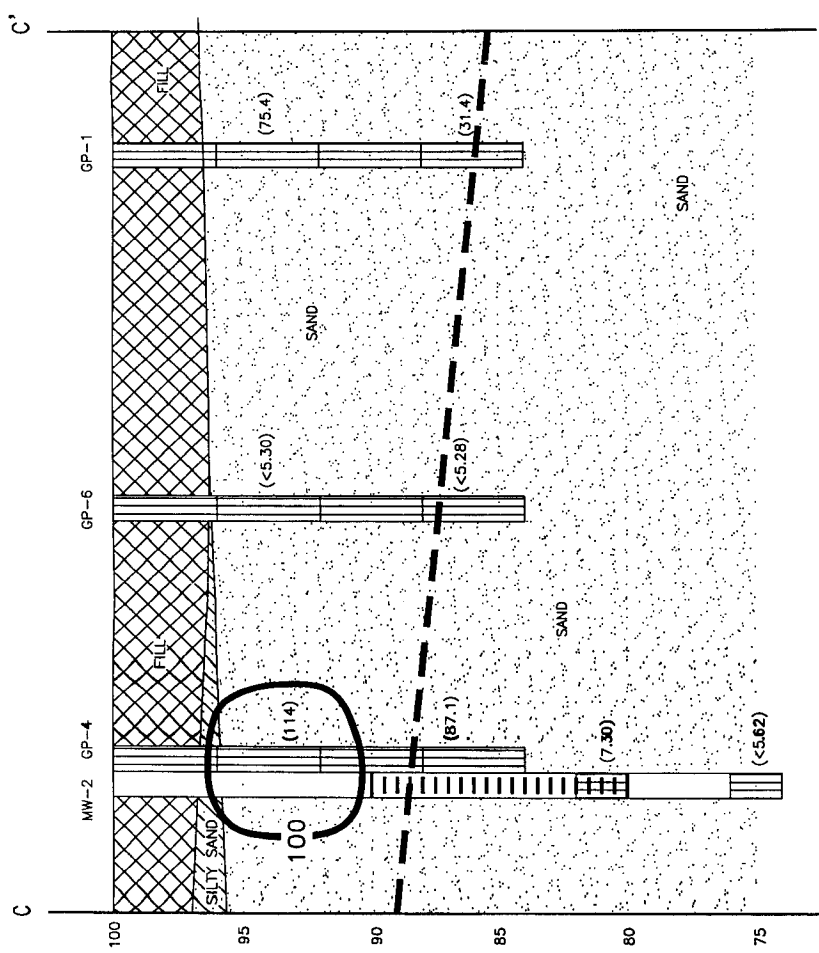


August 21, 2003

Mr. Shawn Wenzel
Wisconsin Department of Commerce
P.O. Box 8044
Madison, Wisconsin 53708-8044

Re: Northwest Engine & Chassis, 122 West Railroad Avenue, Bruce, Wisconsin 54819
WDNR ID No. 03-55-215305
PECFA ID No. 54819-9999-22

Dear Mr. Wenzel:

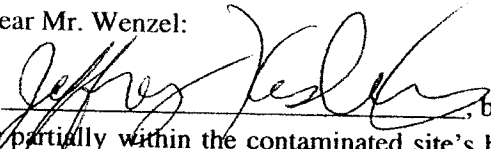I, , believe that legal descriptions for all of the properties within or partially within the contaminated site's boundaries that have soil contamination exceeding generic residual contaminant levels, as determined under ss NR 720.09, at the time case closure is requested, other than public street or highway rights-of-way, have been submitted to the agency with administrative authority for the site as part of the soil GIS registry attachment to the case close out report.

Sincerely,

